



Last saved by: OISIN BURKE(2023-06-20) Last Plotted: 2023-06-20
 Filename: L:\DUBLIN\EDBL2\LEGACY\IEDBL2\PROJECTS\BP60657534\PROJECTS\BP60657534\SUMMERHILL\FIELDSTOWNS\0900_CAD_GIS\91\CAD\CULMULLIN\PLANNING\FOLDER60657534-ACM-DWG-514.DWG
 PM Initials : Designer : OB Checked : KMCD Approved : BW

NORTH ELEVATION SCALE 1:350

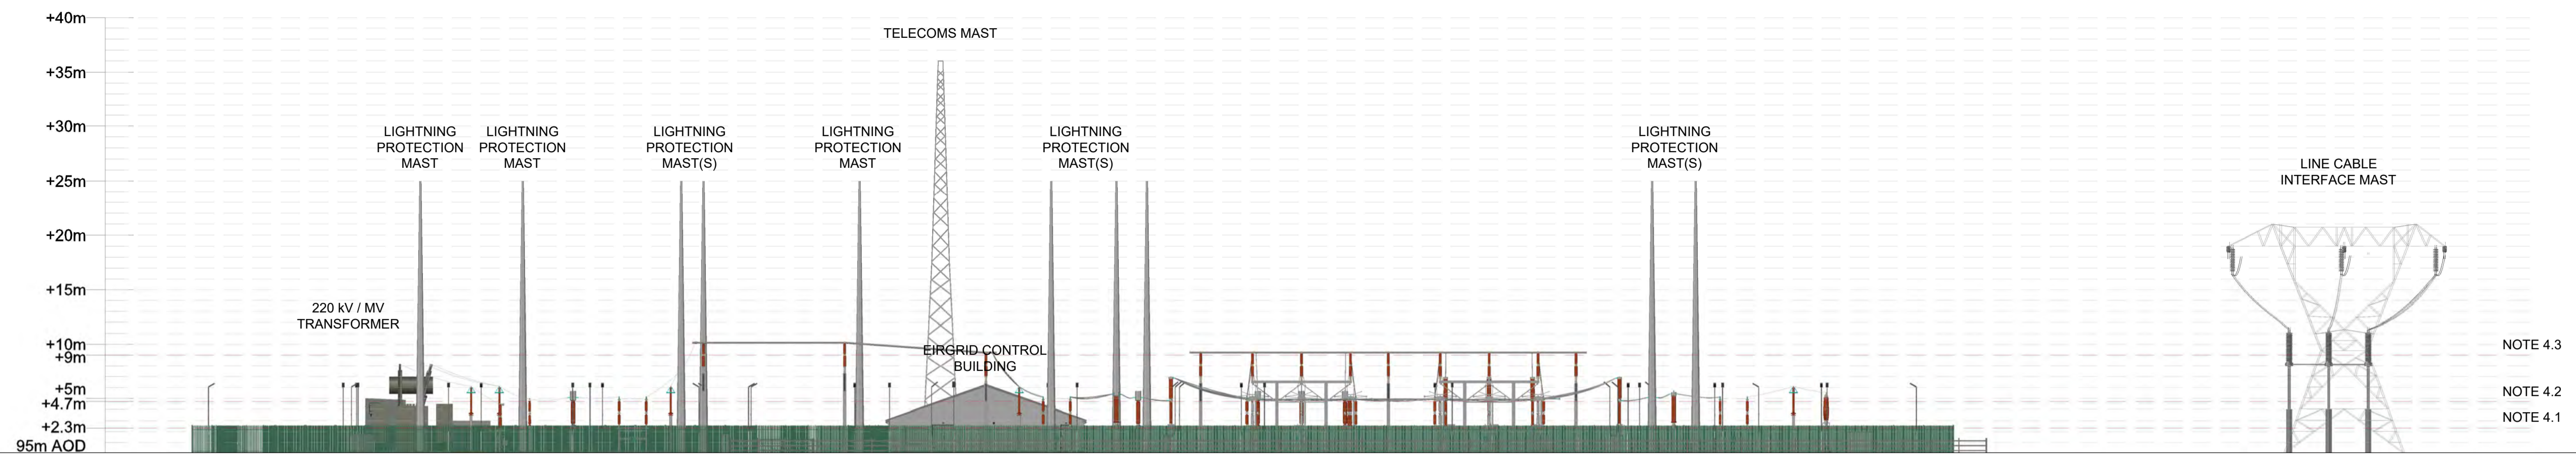


NOTE 4.3
NOTE 4.2
NOTE 4.1

EAST ELEVATION SCALE 1:350

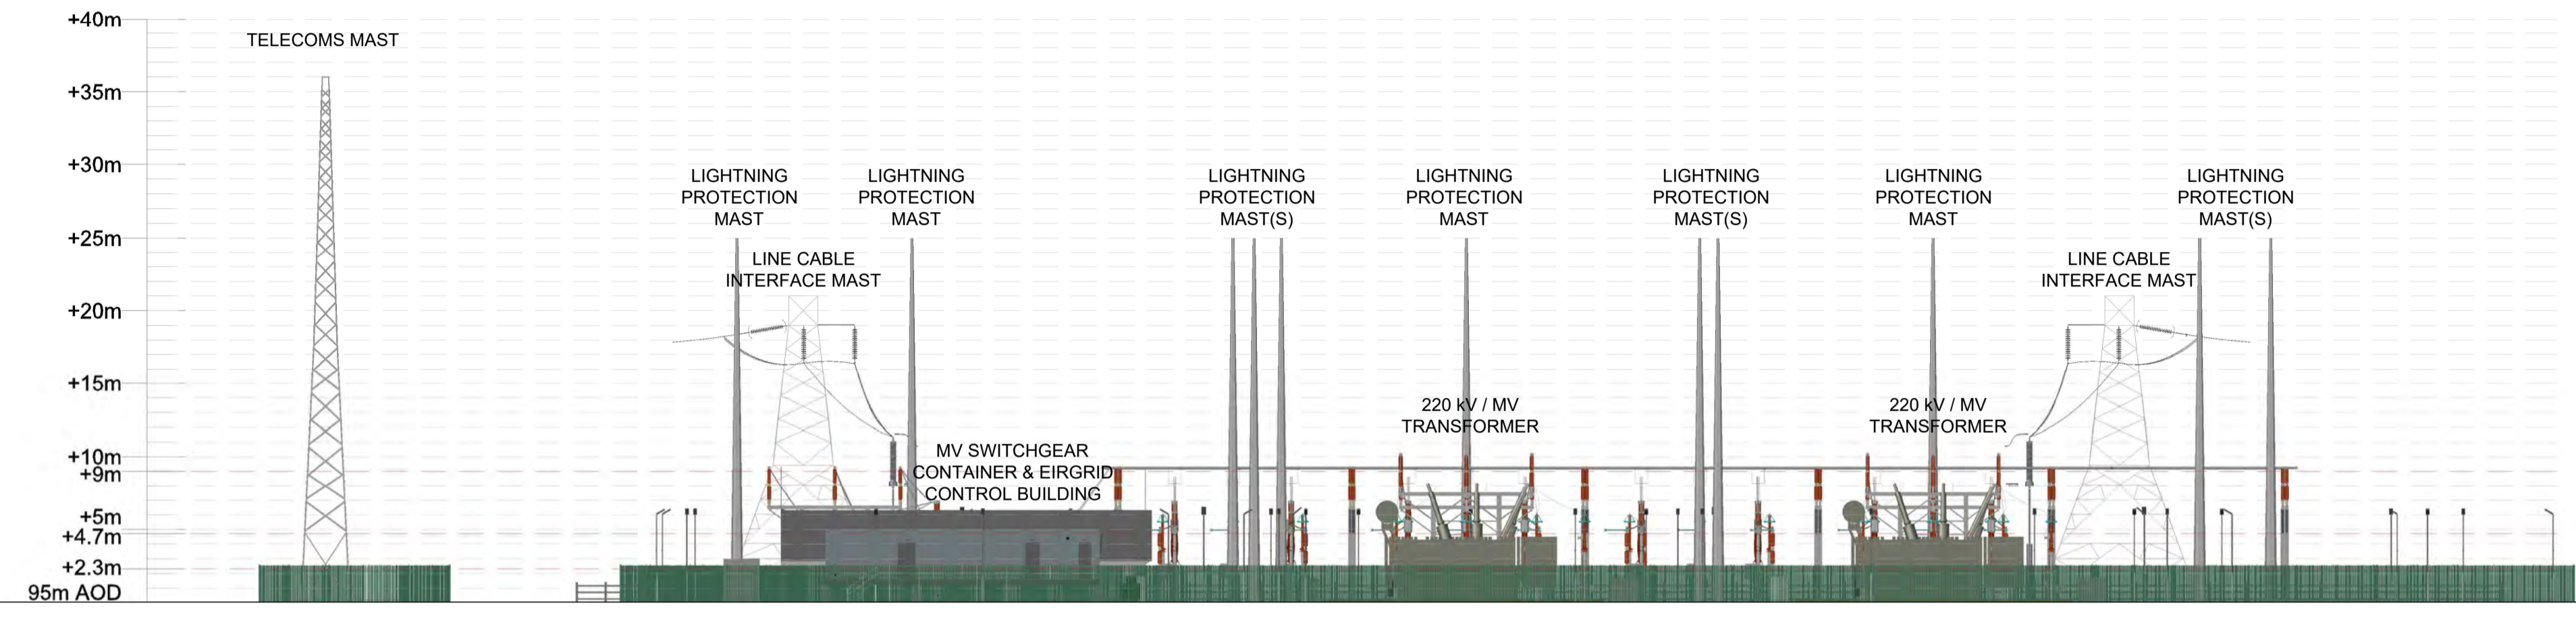


NOTE 4.3
NOTE 4.2
NOTE 4.1

WEST ELEVATION SCALE 1:350

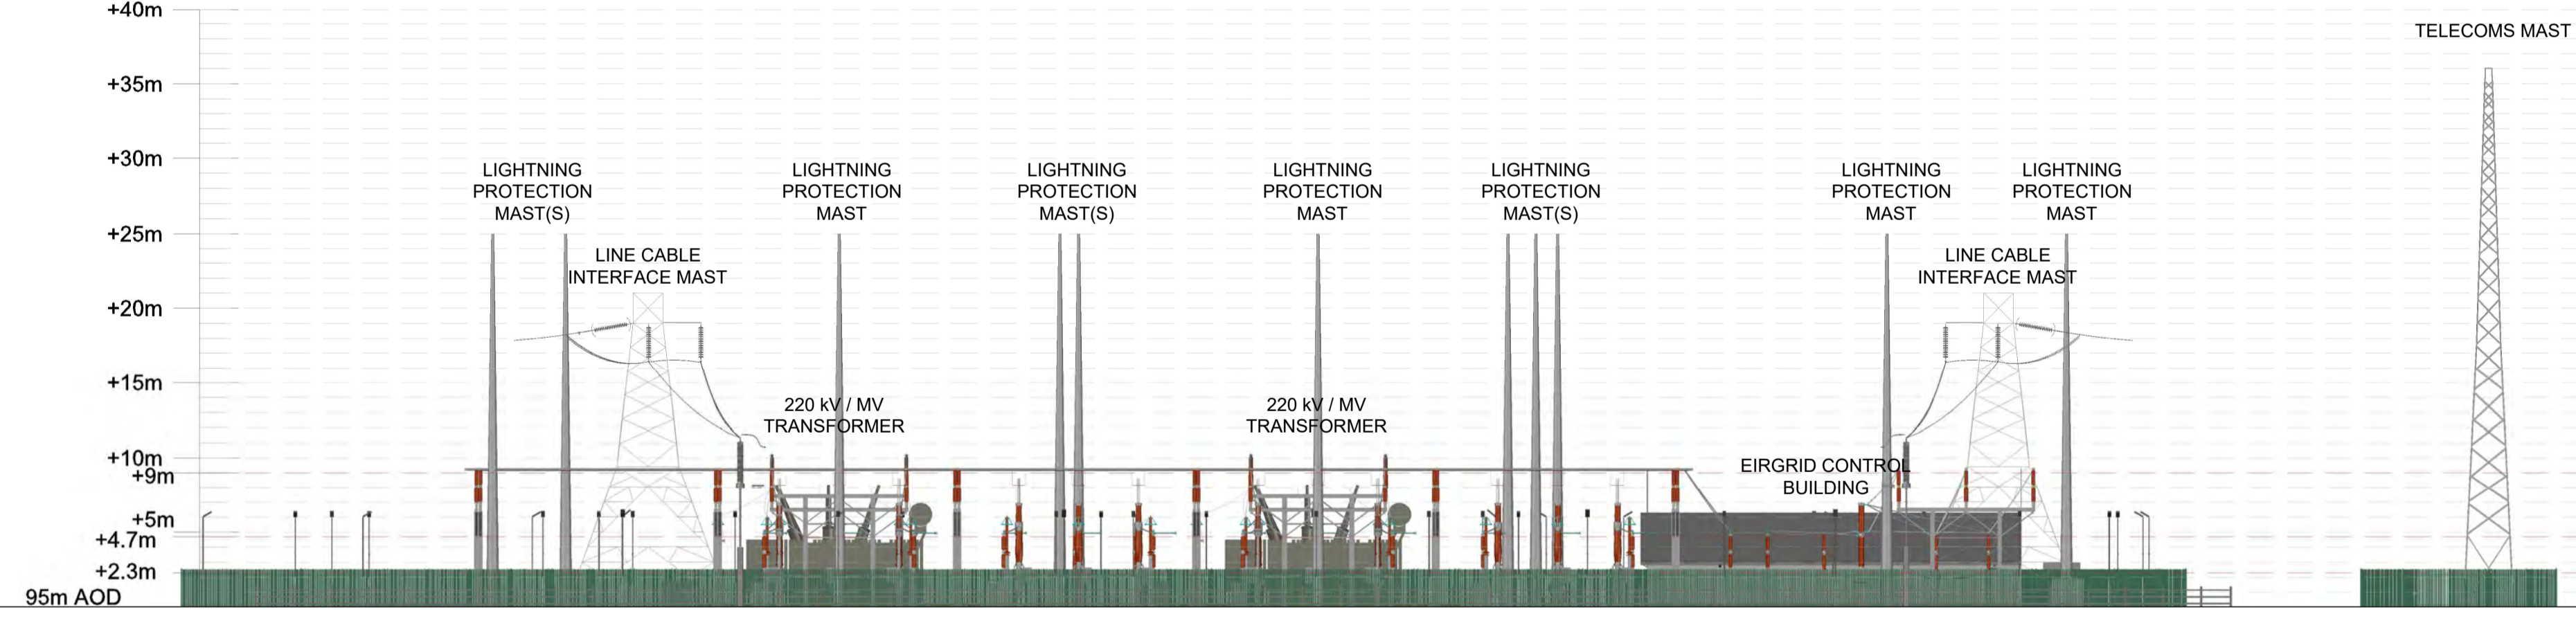

NOTE 4.3
NOTE 4.2
NOTE 4.1

SOUTH ELEVATION SCALE 1:350

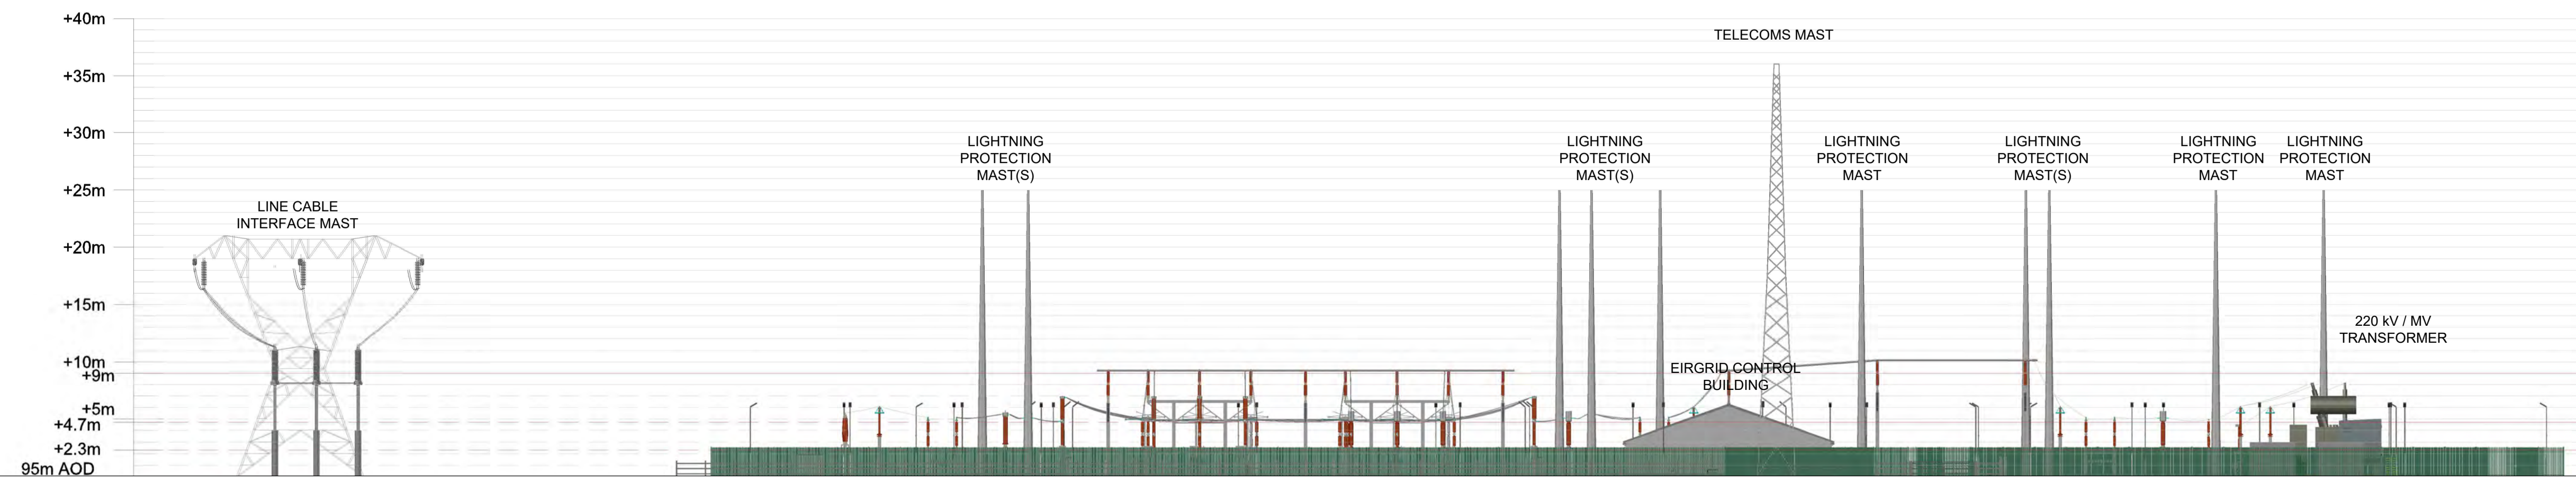

NOTE 4.3
NOTE 4.2
NOTE 4.1



PROJECT
CULMULLIN 220kV
SUBSTATION

CLIENT
ENERGIA SOLAR
HOLDINGS LTD.



CONSULTANT
AECOM
Adelphi Plaza
Georges Street Upper
Dun Laoghaire
County Dublin
Ireland
T +353 (0)1 2383100
www.aecom.com

LEGEND

NOTES

- DRAWINGS ARE FOR PLANNING ONLY AND SHOULD NOT BE USED FOR DETAILED DESIGN, EQUIPMENT DIMENSIONS MAY CHANGE ONCE EXACT SPECIFICATIONS ARE DETERMINED;
- THE SUBSTATION IS BASED ON THE LATEST EIRGRID STANDARD (XDN-LAY-ELV-STND-F-001-R02 AS OF 13/02/2020);
- REFERENCE TO TABLE 4 FOR 220 kV IN THE XDS-GFS-00-001-R4 STANDARD;
- THIS DRAWING IS NOT TO BE SCALED, ALL DIMENSIONS ARE IN METERS.

ISSUE/REVISION

NO	DATE	DESCRIPTION
P4	20/06/2023	FOR PLANNING
P3	09/11/2022	CLIENT COMMENTS
P2	10/10/2022	CLIENT COMMENTS
P1	19/09/2022	ISSUE FOR PLANNING
P0	27/05/2022	FIRST ISSUE FOR PLANNING
I/R	DATE	DESCRIPTION

STATUS

FOR PLANNING

PROJECT NUMBER 60657534 **SCALE** 1:350 @ A1

SHEET TITLE
CULMULLIN 220 kV SUBSTATION
ELEVATIONS 1 TO 4
SHEET 4 OF 4

SHEET NUMBER 60657534-ACM-DWG-514 **REV** P4

This drawing has been prepared for the use of AECOM's client. It may not be used, modified, reproduced or relied upon by third parties, except as agreed by AECOM or as required by law. AECOM accepts no responsibility, and denies any liability, whatsoever, to any party that uses or relies on this drawing without AECOM's express written consent. Do not scale this document. All measurements must be obtained from the stated dimensions.